

The Corporation of the Town of Milton Committee of Adjustment and Consent

Thursday, November 28, 2024, 6:00 p.m.

Council Chambers - In Person

The Town of Milton is resuming the Committee of Adjustment and Consent (COA) meetings in person as of January 26, 2023. Applicants and interested parties can participate in person at Town Hall, Council Chambers, 150 Mary Street.

			Pages					
1.	AGE	NDA ANNOUNCEMENTS / AMENDMENTS						
2.	DISCLOSURE OF PECUNIARY INTEREST HOUSEKEEPING ITEMS MINUTES 4.1 Minutes from Committee of Adjustment October 24, 2024 ITEMS FOR CONSIDERATION 5.1 A24-051/M 1316 Britton Crescent A Minor Variance is being requested to facilitate the construction of a							
3.	HOU	SEKEEPING ITEMS						
4.	MINUTES							
	4.1	Minutes from Committee of Adjustment October 24, 2024	3					
5.	ITEM	IS FOR CONSIDERATION						
	5.1	A24-051/M 1316 Britton Crescent A Minor Variance is being requested to facilitate the construction of a rear yard porch/ veranda (patio cover on top of an existing concrete slab).						
	5.2	A24-054/M 1261 Rose Way A Minor Variance is being requested to facilitate the construction of an Additional Dwelling Unit in the basement. The applicant is seeking relief to the Zoning By-law to permit an existing porch to encroach into the 1.2 metre unobstructed pedestrian access, resulting in a setback of 0.24 metres.	17					
	5.3	A24-054/M 1416 Sycamore Garden A Minor Variance is being requested to facilitate the construction of an Additional Dwelling Unit in the basement. The applicant is seeking relief to the Zoning By-law to permit a chimney to encroach into the 1.2 metre unobstructed pedestrian access, resulting in a setback of 0.25 metres.	21					
6.		T MEETING						

Thursday, December 12, 2024 commencing at 6:00 p.m.

7. ADJOURNMENT

Note: Should the livestream of this meeting be interrupted due to technical reasons, a recording of the meeting's proceedings will be posted to the Town website as soon as reasonably possible.



The Corporation of the

Town of Milton

Committee of Adjustment Minutes

October 24, 2024, 6:00 p.m.

The Committee of Adjustment for the Corporation of the Town of Milton met in regular session in person. All members were present.

- 1. AGENDA ANNOUNCEMENTS / AMENDMENTS
- 2. DISCLOSURE OF PECUNIARY INTEREST
- 3. HOUSEKEEPING ITEMS
- 4. MINUTES
 - 4.1 Minutes from Committee of Adjustment September 26, 2024

THAT the Minutes from the September 26, 2024 Committee of Adjustment and Consent Hearing be **APPROVED**

Carried

5. <u>ITEMS FOR CONSIDERATION</u>

5.1 A24-042/M - 180-294 Bronte Street South

The Applicant provided an overview of the requested Minor Variances

THAT the application for minor variance **BE APPROVED SUBJECT TO**THE FOLLOWING CONDITION:

1. That the applicant receive Site Plan Approval, including the approval of any required Transportation Demand Management measures, within three (3) years of the approval of this Minor Variance.

5.2 A24-046/M - 206 Martin Street

The Applicant provided an overview of the requested Minor Variances

THAT the application for minor variance **BE APPROVED SUBJECT TO**THE FOLLOWING CONDITIONS:

- That the development proceed generally in accordance with the Site Plan and Elevations, prepared by Matthew Design and Drafting Services Inc., date stamped by Town Zoning on September 6, 2024.
- 2. That prior to Building Permit issuance, a Stormwater Management Brief and Grading Plan be provided, to the satisfaction of Development Engineering.
- 3. That a Building Permit be issued within two (2) years from the date of this decision; and,
- That the approval be subject to an expiry of two (2) years from the date of decision if the conditions are not met, if the proposed development does not proceed and/or a Building Permit is not secured.

Carried

5.3 A24-047/M - 467 Violet Gate

The Applicant provided an overview of the requested Minor Variances

THAT the application for minor variance **BE APPROVED SUBJECT TO THE FOLLOWING CONDITIONS**:

- 1. That a Building Permit be obtained within two (2) years from the date of this decision; and,
- That the approval be subject to an expiry of two (2) years from the date of decision if the conditions are not met, if the proposed development does not proceed, and/or a Building Permit is not secured.

Carried

5.4 A24-048/M - 1400 Farmstead Drive

Planner Madison Polidoro provided an overview of the requested Minor Variances as the Owner and/or representative was absent from the Hearing

THAT the application for minor variance **BE APPROVED SUBJECT TO**THE FOLLOWING CONDITIONS:

- 1. That prior to Occupancy Permit issuance, a Building Permit is obtained to legalize the finished basement.
- 2. That an Occupancy Permit for a Short-Term Rental unit be obtained within two (2) years from the date of this decision; and,
- That the approval be subject to an expiry of two (2) years from the date of decision if the conditions are not met, if the proposed development does not proceed and/or an Occupancy Permit is not secured.

Carried

5.5 A24-049/M - 4193 20 Side Road

The Applicant provided an overview of the requested Minor Variances

THAT the application for minor variance **BE APPROVED SUBJECT TO**THE FOLLOWING CONDITIONS:

- 1. That a building permit application be obtained within two (2) years from the date of this decision; and,
- That the approval be subject to an expiry of two (2) years from the date of decision if the conditions are not met, if the proposed development does not proceed and/or a building permit is not secured.

Carried

5.6 A24-050/M - 8490 Parkhill Drive

The Applicant provided an overview of the requested Minor Variances

THAT the application for minor variance **BE APPROVED SUBJECT TO**THE FOLLOWING CONDITION:

1.	That the applicant obtain Site Plan Approval within two (2) years	3
	rom the date of decision.	

Carried

6. <u>NEXT MEETING</u>

Thursday, November 28, 2024 commencing at 6:00 p.m.

7. <u>ADJOURNMENT</u>

With there being no further business, the Chair adjourned the meeting at 6:28 PM

Scott Corbett, Secretary Treasurer



Report To: Committee of Adjustment and Consent

From: Madison Polidoro

Date: November 28, 2024

File No: A-24-051M

Subject: 1316 Britton Crescent

Recommendation: THAT the application for minor variance BE APPROVED

SUBJECT TO THE FOLLOWING CONDITION:

1. That the development shall be located and constructed in accordance with the site plan and building elevations, prepared by Donya Abasiliasi. date stamped by Town Zoning on October 18th, 2024.

- 2. That a building permit application be obtained within two (2) years from the date of this decision; and,
- That the approval be subject to an expiry of two (2) years from the date of decision if the conditions are not met, if the proposed development does not proceed and/or a building permit is not secured

General Description of Application

Under Section 45(1) of the Planning Act, the following minor variance to Zoning By-law 016-2014, as amended, has been requested to permit:

• Requesting permission to allow the rear yard setback to be 2.07 metres, whereas the Zoning By-law requires a minimum of 3 metres.

The subject property is known municipally as 1316 Britton Crescent and is generally located south east of the intersection of Louis St. Laurent Avenue and Regional Road 25. The subject property contains a single-detached dwelling with an attached garage as well as a small accessory structure.

The applicant is proposing a build a rear yard porch/veranda (patio cover on top of an existing concrete slab) in the rear yard. Due to the size of the cover, a variance is require in order to allow a rear yard setback of 2.07 metres whereas the Zoning By-law requires a minimum of 3 metres.

Official Plan Designation (including any applicable Secondary Plan designations)

The subject property is designated Residential Area on Schedule B - Urban Land Use Plan within the Town of Milton Official Plan and is further designated Residential Area within the Boyne Survey Secondary Plan. These designations establish that the primary use of land shall be a mix of low,



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Official Plan Designation (including any applicable Secondary Plan designations)

medium and high density residential development. A variety of medium and high density residential uses are permitted.

It is Staff's opinion that the proposal is in conformity with the Town of Milton Official Plan.

Zoning

The subject lands are zoned Site Specific Residential Medium Density 1 (RMD1*220) under the Town of Milton Zoning By-law 016-2014, as amended. The RMD1*220 zone permits a variety of residential uses, including detached and townhouse dwellings.

Section 4.19.5 i), Table 4H of the Zoning By-law requires a rear yard setback of 3 metres. The proposed structure encroaches in to the rear yard setback, leaving a setback of 2.07 metres.

Consultation

Public Consultation

Notice for the hearing was provided pursuant to the Planning Act on November 13th, 2024. As of the writing of this report on, November 20th 2024, staff have not received any comments from members of the public

Agency Consultation

No objections were filed with respect to the variance application from Town staff or external agencies.

Development Services Comments

The applicant has requested a minor variance to facilitate the construction of a proposed porch/veranda. The subject property currently contains a singled detached dwelling and an accessory structure.

The application was previously heard by the Committee of Adjustments, and the requested relief to the Zoning By-law was denied. The applicant has since revised the drawing based on feedback from Planning Staff. Planning Staff have reviewed the updated drawings and have no objection to the proposed variance.

The proposed reduction of the rear yard setback is minor in nature and does not lead to over development of the lot. The application will not have impact on the functionality of the lot or impact adjacent lots. The revisions to the drawings have allowed for access throughout the lot as well as ensure there is adequate rear yard amenity space.

Planning Staff have reviewed the request to allow a reduced rear yard setback in order to facilitate the construction of a porch/veranda and offer no objection to the proposed variance approval. Planning Staff are of the opinion that the relief being requested is minor in nature, desirable for the



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Consultation

development of the subject lands, maintains the intent of the Zoning By-law and conforms to the Official Plan.

Respectfully submitted,


Madison Polidoro


Planner, Development Review

For questions, please contact: Madison.Polidoro@Milton.ca Phone: Ext. 2311

Attachments

Figure 1 - Site Plan (1316 Britton Crescent) dated October 18th, 2024.

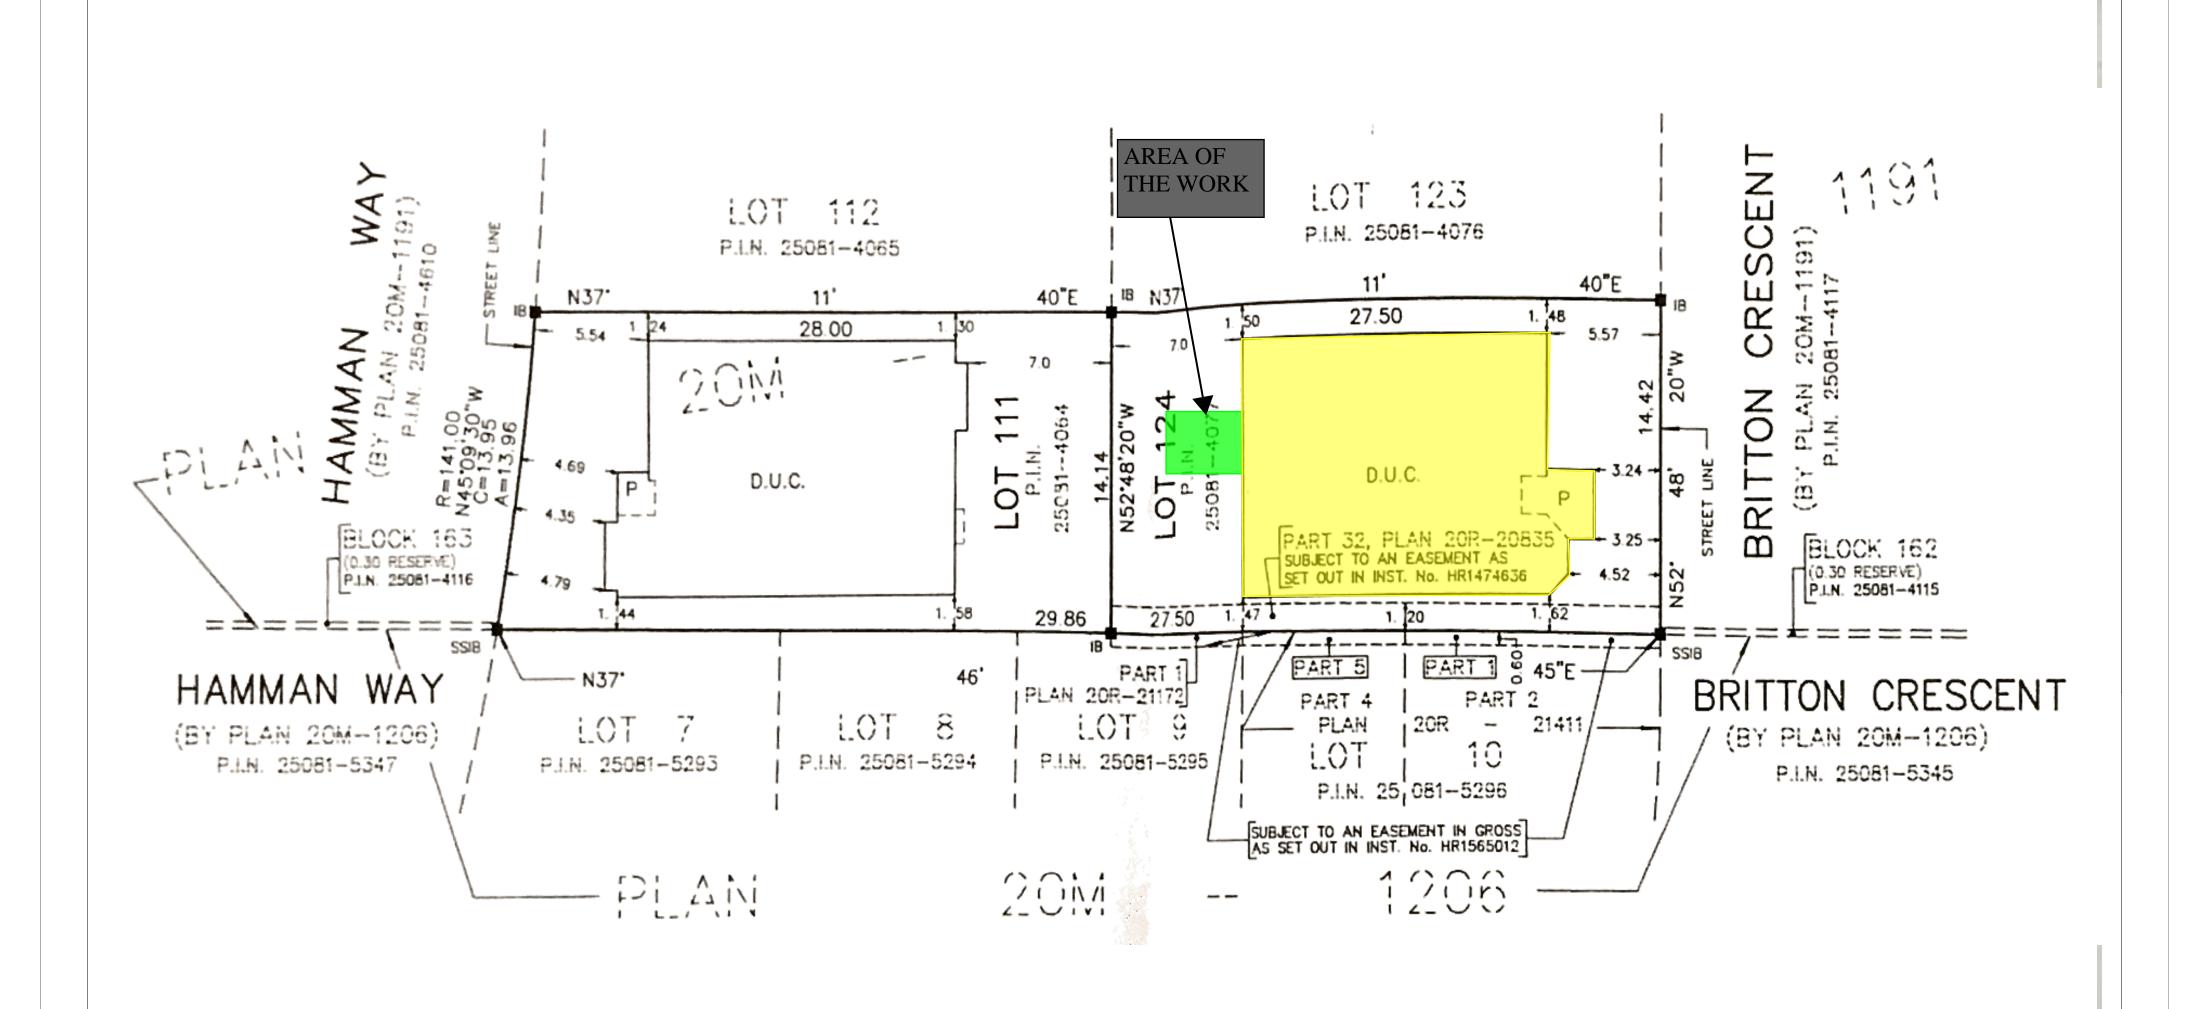

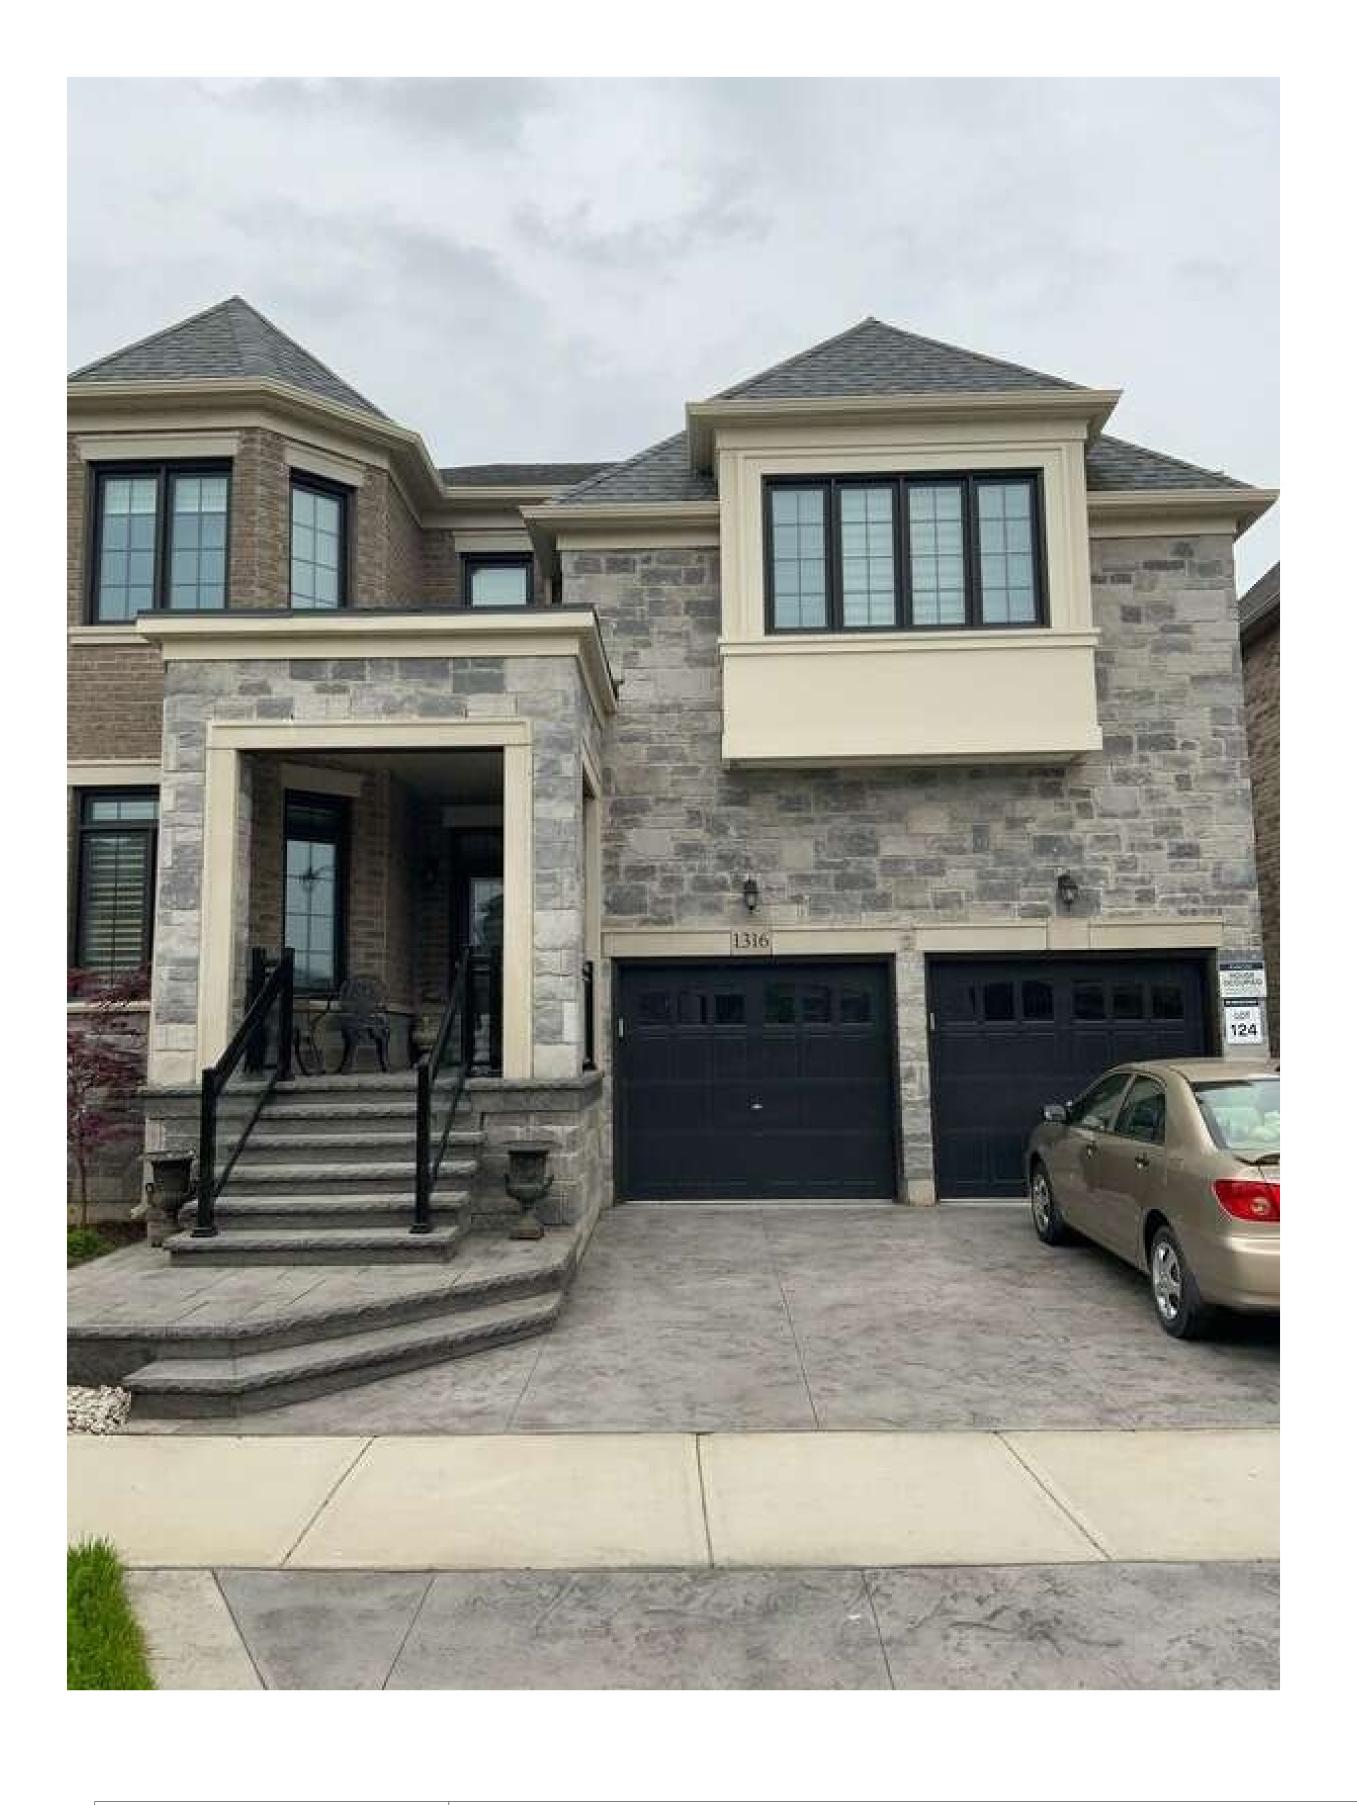



1316 Britton Cres Milton, ON

Drawing Title Site plan

Drawn by
Scale
1:100
Date
October 2024

CONSTRUCTION SPECIFICATIONS

(1) STUCCO FINISH WALL ACRYLIC STUCCO (DUROCK OR APPROVED EQUAL) ON 2" THICK STYROFOAM ON 2 INICA STRUPUAM ON EXTERIOR TYPE SHEATHING 2"x4" WOOD STUDS @ 16" O.C. R 22 BATT INSUL. IN CONTINUOUS CONTACT W/ EXTERIOR SHEATHING CONTINUOUS AIR / VAPOUR BARRIER 1/2" INTERIOR DRYWALL FINISH DOUBLE PLATE @ TOP DOUBLE PLATE @ TOP

SOLE PLATE @ BOTTOM

4"FACE BRICK OR STONE, 1" AIR SPACE 1"X"X22GA MTL TIES AT 16"O/C HORIZ. & 24"O/C VERT. 15]b, BUILDING PAPER PLYWOOD 1/2" EXTERIOR GRADE PLYWOOD 2"X4" WD STUDS AT 16"O/C W/ R22 BATT INSULATION & 6 MIL POLY. VAPOUR BARRIER 1/2" INTERIOR DRYWALL FINISH

PROVIDE WEEP HOLES AT 24"0/C
BOTTOM COURSE ONLY & OVER
OPENINGS. PROVIDE BASE FLASHING
6"MIN. UP BEHIND BUILDING PAPER

BITUMINOUS DAMPPROOFING ON 10" THICK POURED CONCRETE REINFORCED FDN. WALLS, AS SHOWN. PROVIDE PARGING COVED OVER 28"X 8" POURED CONC. FOOTING

28 X 8 POURED CONC. FOOTING TO BEAR ON UNDISTURBED SOIL PROVIDE DRAINAGE LAYER - MIN. 3/4" MINERAL FIBRE INSULATION W/ A DENSITY OF NOT LESS THAN 3.6 LB./FT. OR - MIN. 4" OF FREE DRAINING CRANILL AP MATERIAL OR CRANILL AP

GRANULAR MATERIAL OR A B.M.E.C. APPROVED DRAINAGE LAYER MATERIAL

5 SILL PLATE 2"X6" SILL PLATE FASTENED TO FOUNDATION WALL WITH MIN. 1/2" DIA. ANCHOR BOLTS EMBEDDED MIN. 4" IN CONCRETE @ 7'-10" O/C. MAX. & PROVIDE CAULKING OR GASKET BETWEEN PLATE & FOUNDATION WALL

(6) FLOOR INSULATION CONTINUOUS HEADER JOIST WITH R31 BATT INSULATION, EXTEND
VAPOUR / AIR BARRIER & SEAL
TO JOIST AND SUBFLOOR

(7) BASEMENT INSULATION

2"X4" STUDS @16"0/C C.W. R20ci BATT INSULATION, 6MIL POLY VAPOUR BARRIER,1/2" DRYWALL.

 $\langle s \rangle$ SLAB ON GROUND

3" POURED CONCRETE SLAB WITH 3/4" C/TOPPING (3600 PSI CONC. STRENGTH)
4" CRUSHED STONE BELOW (OBC 9.16.2.1)
EXTENDED TO FOOTING AROUND THE PERIMETER OF C/SLAB BOND BREAKING MATERIAL SHALL BE PLACED BETWEEN SLAB AND E/WALL

(9) DRAINAGE 4" DIA. WEEPING TILE W/ 6" CRUSHED STONE COVER

2 BRICK (STONE) VENEER WALL: 10 ROOF CONSTRUCTION 20 YEAR ASPHALT SHINGLES ON MIN. 5/8" EXTERIOR PLYWOOD SHEATHING ON APPROVED ROOF TRUSSES OR CONVENTIONAL FRAMING (SEE PLANS) USE 'H' CLIPS IF 24" O.C. SPACING

> (11) OVERHANG CONSTRUCTION PREFINISHED ALUMINUM FASCIA, EAVESTROUGH & RAIN WATER LEADERS TO MATCH EXISTING FINISHES. PROVIDE DRIP EDGE AT FASCIA & VENTED SOFFIT EXTEND DOWNSPOUTS TO GRADE LEVEL

4 FOUNDATION WALL: (REFER TO 0.B.C. 9.15.3. & 9.15.4.) $\langle 12 \rangle$ ROOF VENTILATION 1:150 OF THE INSULATED CEILING AREA UNIFORMLY DISTRIBUTED.

> (13) EAVES PROTECTION EAVES PROTECTION MEMBRANE TO EXTEND FROM THE EDGE OF THE ROOF, 36" UP THE SLOPE BUT NOT LESS THAN 12" BEYOND THE INTERIOR FACE OF THE EXTERIOR WALL

(14) CEILING CONSTRUCTION 5/8" INTERIOR DRYWALL FINISH CONTINUOUS AIR / VAPOUR BARRIER W/ MINIMUM R 60 BATT INSULATION

(15) WALL INSULATION CARRY MIN. R22 INSULATION TO COVER THE INTERIOR FACE
OF THE EXTERIOR WALL

(16) FLOOR CONSTRUCTION 3/4" T&G PLYWOOD SUBFLOOR FLOOR JOISTS @ 16" O/C. FLOOR JOISTS BRIDGED W/ CONTINUOUS 1"X3" STRAPPING OR 2 ROWS OF 2"X2" CROSS BRIDGING OR SOLID BLOCKING

(17) INTERIOR STUD PARTITION 1/2" DRYWALL FINISH BOTH SIDES OF 2"X4" OR 2"X6"WOOD STUDS @ 16" O/C 2 TOP PLATES & 1 BOTTOM PLATE PROVIDE SOUND ATTENUATION INSULATION IN BATHROOM WALLS & WHERE INDICATED ON PLAN

(18) MECHANICAL VENTILATION PROVIDE MIN. 1 AIR CHANGE PER HOUR IN ROOMS SPECIFIED TO BE MECHANICALLY VENTED 80 CFM FOR BATH PRIMARY VENTS

(19) STAIRS INTERIOR/EXTERIOR

MAXIMUM RISE = 4 7/8" = 8 1/4" = 14" MINIMUM RISE MINIMUM RUN MAXIMUM RUN MINIMUM TREAD MAXIMUM TREAD 9 1/4" 14" 1" MAXIMUM NOSING MINIMUM WIDTH MINIMUM HEADROOM

⟨20⟩ GUARDS

= 2'-11" = 3'-6" = 2'-11" = 2'-11" = 4" INTERIOR LANDINGS EXTERIOR BALCONY INTERIOR STAIRS EXTERIOR STAIRS MAX. BETWEEN PICKETS

GUARD HEIGHT IF DECK TO GRADE IS:
GREATER THAN 5'-11"
5'-11" OR LESS
NO MEMBER OR ATTACHMENT
BETWEEN 4" & 2'-11" HIGH
SHALL FACILITATE CLIMBING

(21) ATTIC ACCESS PROVIDE ATTIC ACCESS MIN. 20"X 28" W/ INSULATION & WEATHER STRIPPING

(22) INSTALL A CARBON MONOXIDE DETECTOR CONFORMING TO CAN/CGA-6.19 OR UL 2034

PROVIDE SOLID BEARING ON MASONRY FOR BEAMS AND /OR COLUMNS

(24) GARAGE CEILING:

3/4"T&G PLYWOOD SUBFLOOR 6 ML POLY. VAPOUR BARRIER 2"x10" MD JOISTS (SEE PLAN FOR SPACING) W/R31 BATT INSUL. & 5/8" GYPSUM BOARD (SMOKE PROOF JOINTS)

(25) GARAGE SLAB:

4"CONC. SLAB W/6x6 W.W.M. ON 6"CRUSHED STONE (COMPACTED) CONC. STRENGTH 25MPa AT 28 DAYS W/5-8% AIR ENTRAINMENT

(26) GRADE

SLOPE GRADE AWAY FROM BUILDING FACE & PROVIDE SEMI-SOLID BLOCK COURSE AT OR BELOW GRADE LEVEL

STRUCTURAL NOTES

1. The floor LL = 40 psf (1.9 kPa) , Roof LL = 23.3 psf (1.12 kPo) + snow accumulation 2. The floor and roof DL = 15.00 psf (0.71 kPa) 3. All footings must be carried down to the undisturbed soil capable of sustaining

.... rosangs must be carried down to the undisturbed soil capable of sustaining bearing pressure of 2000 PSF minimum (to be confirmed on the site by a Soil Engineer) Concrete construction shall adhere to CAN/CSA-A23.1 requirements.

5. Concrete for the footings and the slab-on-grade shall have compressive strength of

5. Concrete for the footings and the slab—on—grade shall have compressive strength of 30MPa at 28 days
6. Reinforcing steel to be CSA G 30.18—M1992 deformed bars — Grade 400
7. Masonry construction to conform to CSA A371—94.
8. Use min. 20MPa block units and Type S mortor.
9. Grout solid all the voids in existing masonry and at new reinforced concrete blocks
10. All new wood shall be S—P—F No.2 Grade minimum.
11. All wood connectors to be by
12. Ere@MSPOST SERBELIFED Composite Lumber, MICROLAM LVL or 2.0E ES
PARALLIAM PSI

PARALLAM PSL

must conform to Suppliers specifications
13. All new structural steel to be G40,21—M 300W & 350W for HSS members
14. Fabrication and erection steel shall be carried out in accordance with CAN/CSA-S16.1-94.

CAN/CSA-S16.1-94.

15. Provide solid bearing on existing concrete or masonry for steel beams and columns 16. Wherever it becomes necessary to cut or interfere in any manner with existing equipment or services, the work must be co-ordinated with the Owner 17.All new work must conform to the Ontario Building Code Requirement.

GENERAL STRUCTURAL NOTES

1. ALL CONSTRUCTION TO COMPLY WITH ONTARIO BUILDING CODE 2012 EDITION. DESIGN OF O.B.C. PART 9 MEMBERS IS IN ACCORDANCE WITH THE FOLLOWING LOADING:

2ND FLOOR LOADING: LL - 40.0 PSF DL - 15.0- PSF

GROUND FLOOR LOADING LL - 40.0 PSF DL - 15.0 PSF

MIN. LL DEFLECTION = L/360

2. DRAWINGS SHALL NOT BE SCALED.

3. FOOTINGS SHALL BE POURED ON UNDISTURBED SOIL. EXTERNAL FOOTINGS SHALL BE ERECTED 4'-0'
MINIMUM BELOW GRADE .

DESIGN BEARING CAPACITY - 150 KPa (3000 PSF) EXISTING BEARING CAPACITY - NOT KNOWN. THE CONTRACTOR SHALL BE RESPONSIBLE TO VERIFY THE DESIGN BEARING CAPACITY AND REPORT TO THE ENGINEER OF ANY DISCREPANCIES.

4. CONCRETE SHALL BE $\quad \text{F'c} = 25 \text{ MPa.}$ CONSTRUCTION JOINTS SHALL BE LEFT ROUGH.

5. ALL CONCRETE CONSTRUCTION, WORKMANSHIP AND MATERIALS NOT NOTED IN PART 9 OF THE O.B.C. SHALL BE IN ACCORDANCE WITH CAN/CSA-A23.1 ALL REINFORCEMENT SHALL BE DEFORMED BARS C.S.A. G30.12 WITH Fy=400 MPa. EXTEND CONTINUOS BARS INTO INTERSECTING MEMBERS FOR A DISTANCE OF 36 BAR DIAMETERS AND BENT IF REQUIRED. PROVIDE CONCRETE COVER FOR REINFORCEMENT AS REQUIRED BY O.B.C. AND IN ACCORDANCE WITH AS REQUIRED BY O.B.C AND IN ACCORDANCE WITH CAN/CSA-A23.1

6. ALL STRUCTURAL STEEL SHALL BE C.S.A. G40.21 GRADE 44W. HSS SECTIONS SHALL BE G40.21-50W. FABRICATION, CONNECTION DESIGN AND WELDING SHALL CONFORM TO CAN/CSA-S16.1/94 AND W59-M1989.

7. MINIMUM BEARING OF STRUCTURAL MEMBERS ON MASONRY SHALL BE AS FOLLOWS:

CONCRETE AND STEEL BEAMS 8' CONCRETE SLABS WOOD BEAMS AND JOISTS 4"

BEARING PLATES SHALL BEAR ON 3 COURSES OF 100% SOLID MASONRY WHICH SHALL EXTEND A MINIMUM OF 8" FROM EACH SIDE OF THE PLATE.

ALL BEAMS SHALL BE ONLY TOP BEARING ON STEEL COLUMNS.

MORTAR SHALL BE TYPE "S" OR BETTER WITH A MINIMUM COMPRESSIVE STRENGTH OF 1800 PSI. AT 28 DAYS. (TYP. U/N NOTED ON SECTIONS AND DETAILS)

CONCRETE BLOCKS SHALL HAVE A MINIMUM COMPRESSIVE STRENGTH OVER NET AREA IN ACCORDANCE WITH TABLE 9.20.2.7. AS PER PART 9 OI O.B.C. (TYP. U/N NOTED ON SECTIONS AND DETAILS)

9. REINFORCED MASONRY:

MORTAR SHALL BE TYPE "S" OR BETTER WITH A MINIMUM COMPRESSIVE STRENGTH OF 1800 PSI AT 28 DAYS. DAYS. CONCRETE BLOCKS SHALL HAVE A MINIMUM COMPRESSIVE STRENGTH OF 2950 PSI OVER NET AREA

10. ALL DIMENSIONS AND EXISTING CONDITIONS SHALL
BE VERIFIED BY THE GENERAL CONTRACTOR AT
THE SITE. THE GENERAL CONTRACTOR SHALL BE
RESPONSIBLE TO NOTIFY THIS OFFICE OF ANY
DISCREPANCIES PRIOR TO COMMENCEMENT OF

WORK.

11. FABRICATED ITEMS WHICH FABRICATION AND
DESIGN IS NOT PRESCRIBED IN PART 9 OF THE O.B.C.
SHALL BE PREENGINEEERD AND DESIGNED IN
ACCORDANCE WITH PART 4 OF THE O.B.C. SHOP
DETAILS, DRAWINGS AND DIAGRAMS OF THESE
ITEMS SHALL BE SUBWITTED TO THIS OFFICE FOR
REVIEW PRIOR TO FABRICATION. THESE DRAWINGS
SHALL BE SCALED BY A P. ENG OF ONTARIO
RESPONSIBLE FOR THE DESIGN OF THESE ITEMS
AND CLEARLY INDICATE THE METHOD OF CONNECTION
OF THESE ITEMS TO THE STRUCTURE. THESE
ITEMS SHALL INCLUDE STRUCTURAL STEEL,
REINFORCING BARLISTS, CONNECTIONS
BETWEEN WOOD MEMBERS AS PER HANGER
SCHEDULE AND PRECAST ELEMENTS.

11. ALL FRAMING LUMBER SHALL BE SPF#2 UNLESS NOTED.

12. PLYWOOD SHALL BE 5/8" T@G UNLESS NOTED. PROVIDE EXTERIOR GRADE PLYWOOD WHERE REQUIRED BY 0.B.C.

13. ALL THE JOISTS AND BEAMS LOCATED AT THE SAME ELEVATION SHALL BE CONNECTED WITH JOIST HANGERS, ALL MEMBER CONNECTIONS SHALL MEET THE MINIMUM REQUIREMENTS AS OUTLINED IN PART 9 OF THE ONTARIO BUILDING CODE, UNLESS STRONGER CONNECTIONS ARE SPECIFIED.

14. ALL WOOD POSTS SHALL BE AS PER WOOD POST SCHEDULE.

PROVIDE POST P1 AT ALL WOOD LINTEL BEARINGSS UNLESS NOTED OTHERWISE ON PLANS. ALL WOOD POSTS SHALL BE CONT'S FROM FOOTINGS OR FOUNDATION WALLS TO U/S SUPPORTED BEAMS OR TRUSSES. PROVIDE SOLID BLOCKING AT DISCONTINUITIES SUCH AS FLOOR SPACES. (TYP. AT

ALL WOOD POST LOCATIONS) PROVIDE 100 % SOLID BEARING U/S ALL POSTS AT BEARING. POSTS SHALL BEAR ON MINIMUM OF 3 COURSES OF SOLID MASONRY WHICH SHALL EXTEND A MINIMUM OF 8" FROM EACH SIDE OF THE PLATE OR SOLID CONCRETE.

15. HANGER SIZES SHALL BE AS PER HANGER SCHEDULE THE HANGERS NOTED ABOVE ARE FOR INDICATION OF LVL PLIES AND CONNECTION SHEAR FORCE CAPACITY ONLY. THE ACTUAL SHAPE OR ANGLE OF CONNECTION BETWEEN MEMBERS SHALL BE SURVEYED AT THE SITE BY THE HANGER DESIGNER.

16. ALL MICRO=LAM BEAMS AND "I" TYPE JOISTS SHALL BE BY TRUS JOIST MACMILLAN OR EQUIVALENT. THE INSTALLATION OF THE MICRO-LAM BEAMS AND "I" JOISTS SHALL BE IN ACCORDANCE WITH THE MANUFACTURERS INSTALLATION GUIDELINES AND RECOMMENDATIONS.

17. THE LOAD BEARING STUD WALLS SHALL BE 2 X 6 @ 16" O/C SPF. #2 LUMBER, TYPICAL UNLESS NOTED. PROVIDE BRIDGING OR BLOCKING AT THE STUD WALLS TO GIVE 8'-0" MAXIMUM UNBRACED LENGTH.

18. THE SPACING AND SIZES OF THE ROOF AND THE FLOOR JOISTS SHALL BE NOTED ON THE PLANS. PROVIDE FULL 2" SOLID BEARING AT THE SUPPORTS.

19. THE DESIGN OF THE STRUCTURAL COMPOSITE LUMBER MEMBERS SHALL CONFORM TO THE CSA STANDARD 086.1-94.

THE INSTALLATION OF ALL THE STRUCTURAL COMPOSITE LUMBER BEAMS SHALL BE IN ACCORDANCE WITH THE MANUFACTURERS INSTALLATION GUIDE-LINES AND RECOMMENDATIONS

20. "I" TYPE JOISTS SHALL BE TJI JOISTS AS NOTED IN THE TRUS JOIST CANADA LTD. DESIGN CATALOGUE OR EQUIVALENT. SEE PLANS FOR THE LOCATION AND THE SPACING OF THE "I" JOISTS. TH INSTALLATION OF ALL "I" TYPE JOISTS SHAL BE IN ACCORDANCE WITH THE MANUFACTURERS INSTALLATION GUIDE—LINES AND RECOMMENDATIONS.

21. THE DESIGN AND ERECTION OF THE WOOD TRUSSES SHALL CONFORM TO THE CANADIAN STANDARD CSA-086.1-94 AND THE ONTARIO BUILDING CODE.

22. THE TRUSS FABRICATOR SHALL SUBMIT SHOP DRAWINGS AND ERECTION DIAGRAMS TO THIS OFFICE FOR APPROVAL. THE DRAWINGS SHALL BE STAMPED BY A PROFESSIONAL ENGINEER OF ONTARIO.

23. ALL TYPICAL AND NON-TYPICAL TRUSS BEARINGS SHALL BE CLEARLY INDICATED ON THE SHOP DRAWINGS. ALL REACTIONS OF THE TRUSSES AND THE TRUSSES GIRDERS TO BE INDICATED ON THE SHOP DRAWINGS. LATERAL FORCES ON EXTERIOR BEARING WALLS ARE NOT ALLOWED.

24. THE ERECTION DIAGRAMS SHALL SPECIFY TEMPORARY AND PERMANENT BRACINGS, PROCEDURES AND METHODS REQUIRED BY THE FRAMING CONTRACTOR TO ERECT THE TRUSSES SUCCESFULLY.

25. CP1 SHALL BE 14" Ø R.C. PIER TO U/S OF WOOD POSTS OR STEEL COLUMNS IN GARAGE R.W. 6X15M VERTICALS + 10M TIES @ 10" O/C. PROVIDE GALVANIZED COLUMN BASE CB6X6 BY MGA CONNECTORS AT WOOD POST ENSURE THAT U/S OF POST IS 6" ABOVE FLOOR EL.

ENSURE THAT U/S OF POST IS 6" ABOVE FLOOR EL.

26. ALL DIMENSIONS AND EXISTING CONDITIONS SHALL BE VERIFIED BY THE GENERAL CONTRACTOR AT THE SITE PRIOR TO CONSTRUCTION. THE GENERAL CONTRACTOR SHALL BE RESPONSIBLE TO NOTIFY THE ARCHITECT AND THE ENGINEER OF ANY DISCREPANCIES BETWEEN THE SITE CONDITIONS AND THE ASSUMED DESIGN CONDITIONS PRIOR TO THE COMMENCEMENT OF CONSTRUCTION. IN ADDITION THE GENERAL CONTRACTOR SHALL BE SOLELY RESPONSIBLE FOR THE CONSTRUCTION, METHOD OF FRECTION AND INSTALLATION. PROCEDURES OF THE STRUCTURAL MEMBERS INCLUDING THE ERECTION OF STEEL BEAMS SUPPORTING EXISTING JOISTS. THE GENERAL CONTRACTOR SHALL CONTRACTOR SHALL SUBMIT SHORING DETAILS AND DRAWINGS STAMPED BY P. ENG. OF ONTARIO FOR REVIEW INDICATING THE SHORING PROCEDURE AND METHODS HE WILL EMPLOY TO SUPPORT EXISTING STRUCTURE. THE GENERAL CONTRACTOR SHALL EXERCISE EXTREME CAUTION AND CARE DURING THE DEMOLITION PROCESS OF THE EXISTING STRUCTURE AND MSCORES OF THE EXISTING STRUCTURE AND MSCOREY WALLS AND BE SOLELY RESPONSIBLE FOR THE SUPPORT OF THE EXISTING STRUCTURE AND MSCOREY WALLS AND BE SOLELY RESPONSIBLE FOR THE SUPPORT OF THE EXISTING STRUCTURE AND MSCOREY WALLS AND BE SOLELY RESPONSIBLE FOR THE SUPPORT OF THE EXISTING STRUCTURE DURING THE DEMOLITION. THE GENERAL CONTRACTOR SHALL CALL THE STRUCTURAL ENGINEER FOR AN INSPECTION PRIOR TO CUTTING EXISTING MEMBERS AND REMOVING EXISTING



1316 Britton Cres Milton, ON

Drawing Title

GENERAL NOTE

Page 11 of 24


Drawn by

TONUA ABASI

Scale


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Date

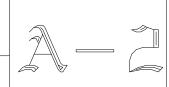

EXISTING GROUND FLOOR PLAN



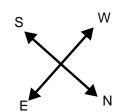


NOTES


- 1. VERIFY ALL DIMENSIONS PRIOR TO CONSTRUCTION.
- 2. DO NOT SCALE DRAWINGS.
- 3. REPORT ALL DISCOVERIES OF ERRORS, OMISSIONS OR DISCREPANCIES TO THE DESIGNER OR DESIGN ENGINEER AS APPLICABLE.
- 4. USE ONLY LATEST REVISED DRAWINGS OR THOSE THAT ARE MARKED "ISSUED FOR CONSTRUCTION".
- 5. THE DRAWINGS ARE NOT FOR CONSTRUCTION DRAWINGS THE DRAWINGS HAVE BEEN ISSUED FOR PERMIT ONLY.

Number of Stories: > 1 Footprint Perimeter: 205' 5" Footprint Area: 1976 ft²

BACK

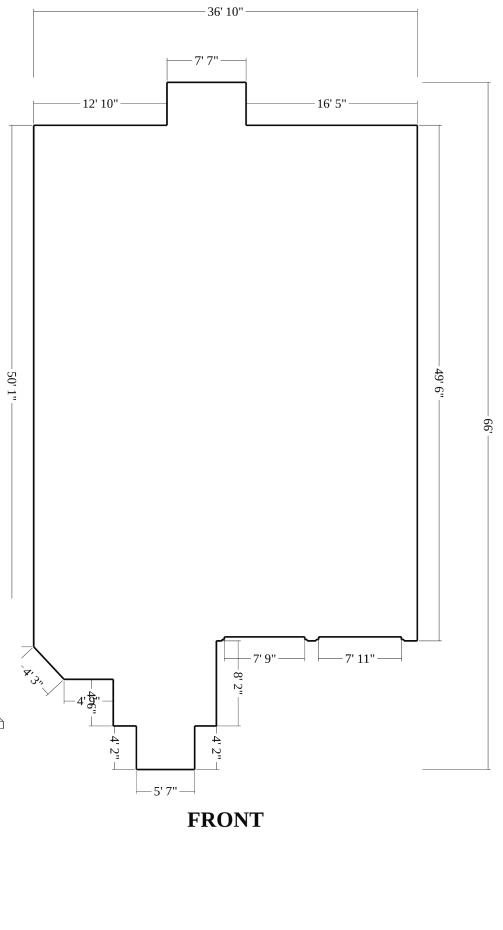



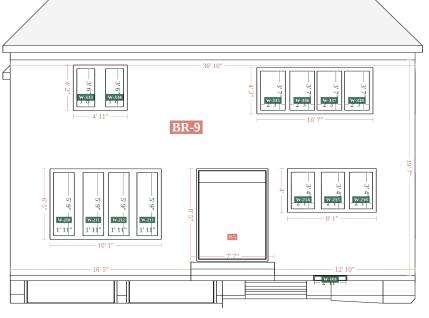

1316 Britton Cres Milton, ON




Drawing Title

EXISTING GROUND FLOOR PLAN

Drawn by

TEAUA AUASI


Scale 1'-0" = 1/8" Date

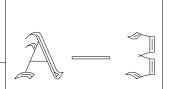

PROPOSED PATIO COVER FLOOR PLAN

NOTES

- 1. VERIFY ALL DIMENSIONS PRIOR TO CONSTRUCTION.
- 2. DO NOT SCALE DRAWINGS.
- 3. REPORT ALL DISCOVERIES OF ERRORS, OMISSIONS OR DISCREPANCIES TO THE DESIGNER OR DESIGN ENGINEER AS APPLICABLE.
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- 5. THE DRAWINGS ARE NOT FOR CONSTRUCTION DRAWINGS THE DRAWINGS HAVE BEEN ISSUED FOR PERMIT ONLY.

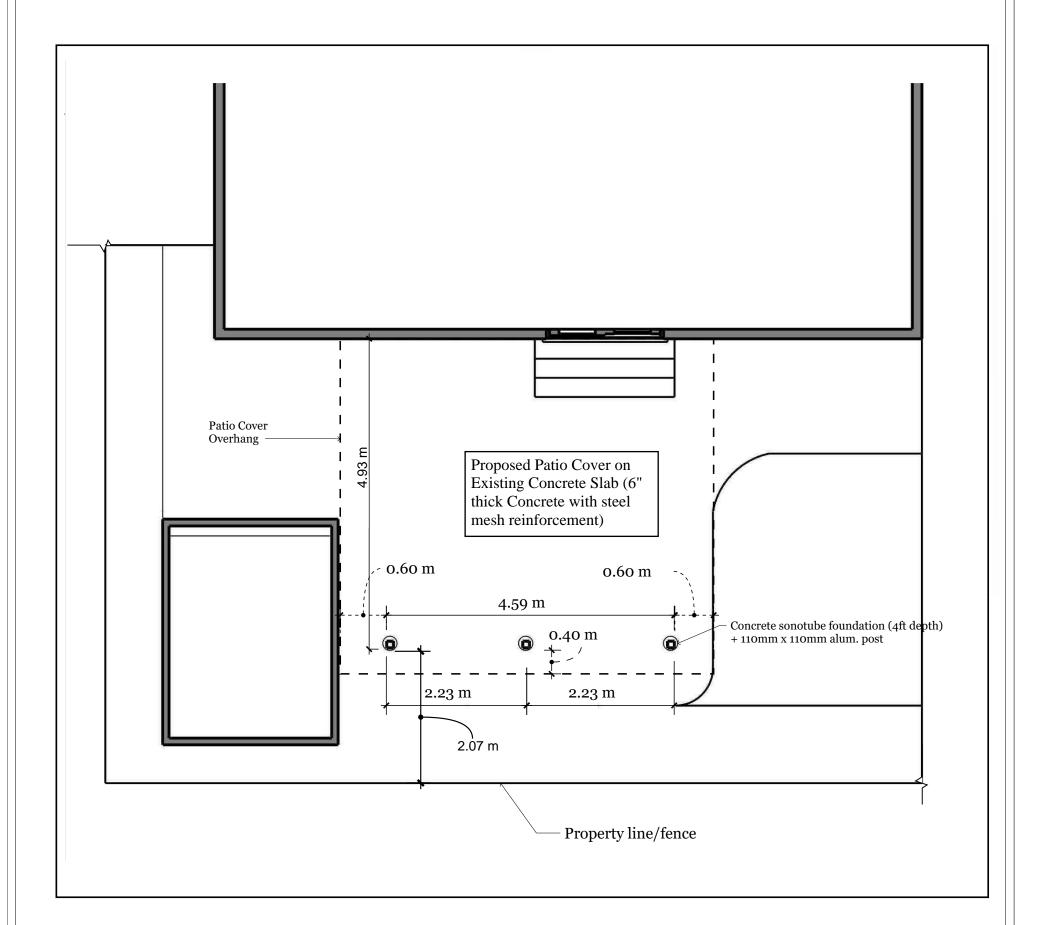

EXISTING GROUND FLOOR AREA: 1,976 SQF

PROPOSED PATIO COVER AREA: 332.17 SQF







1316 Britton Cres Milton, ON

Drawing Title PROPOSED FLOOR PLAN

Drawn by **BONHA ABASI**

Scale 1'-0" = 1/8"

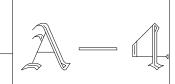

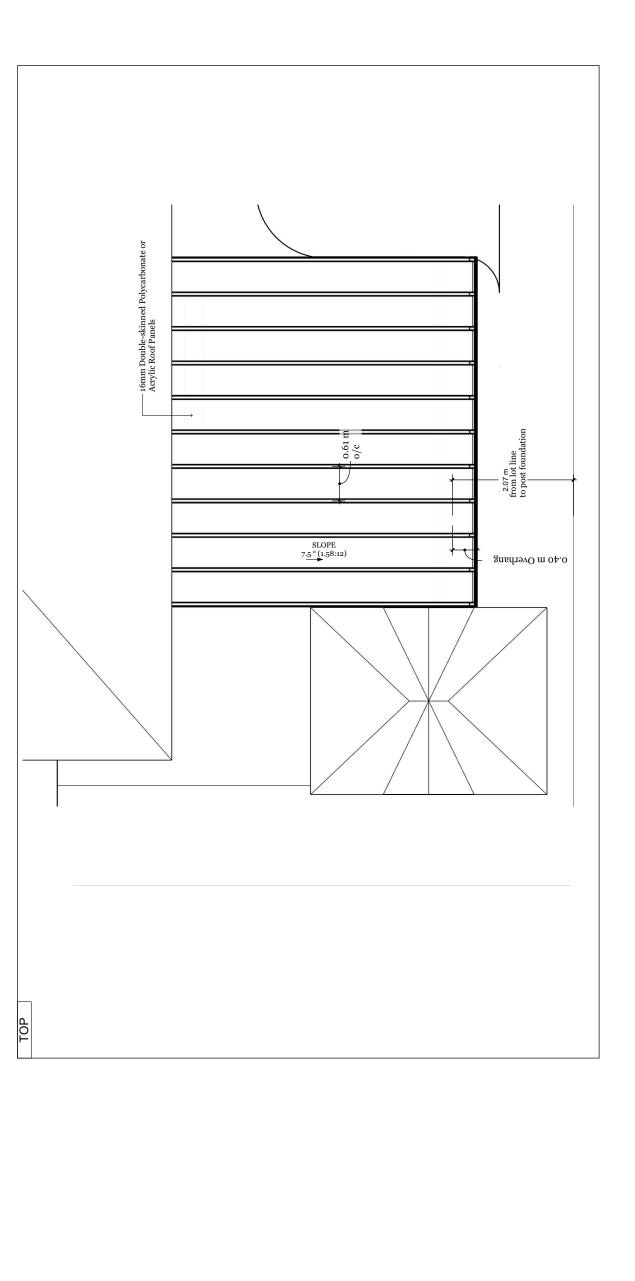


NOTES

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THE DRAWINGS ARE NOT FOR CONSTRUCTION DRAWINGS THE DRAWINGS HAVE BEEN ISSUED FOR PERMIT ONLY.

ENLARGE PLAN



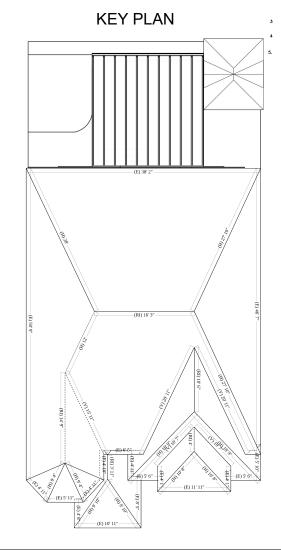


1316 Britton Cres Milton, ON

Drawing Title

PROPOSED ROOF PLAN


Drawn by **BONYA AWASI**

Scale 1'-0" = 1/8"

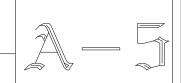

PROPOSED PATIO COVER ELEVATIONS



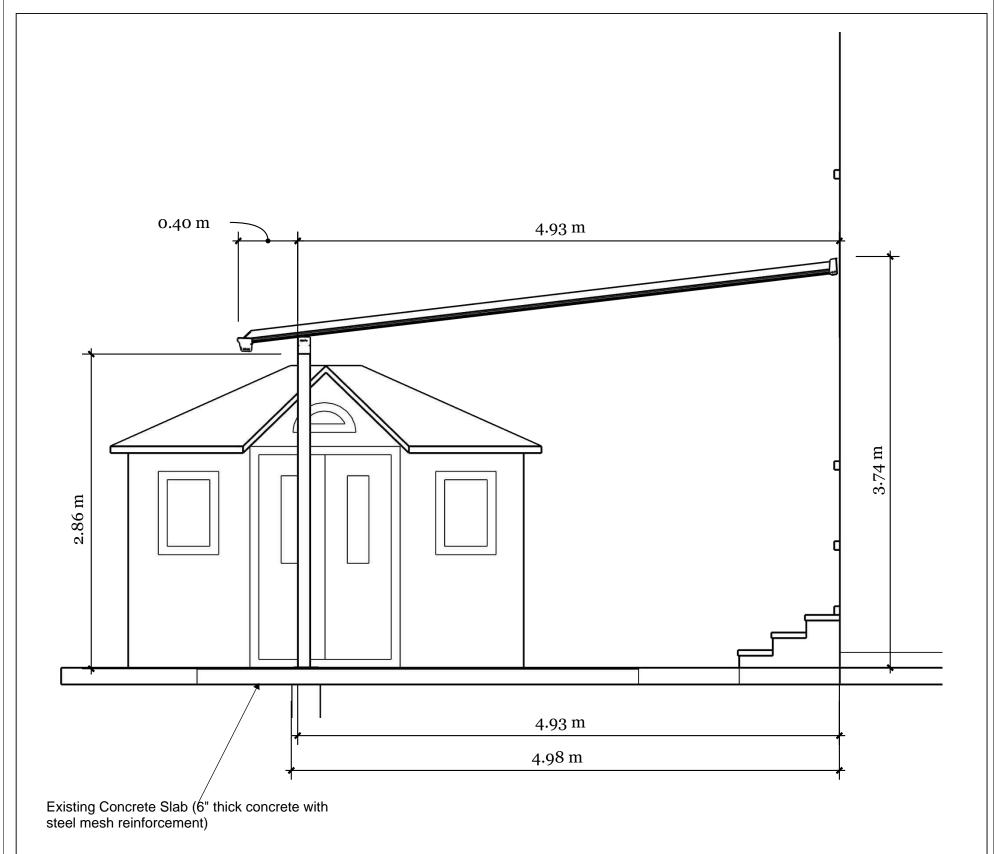



1316 Britton Cres Milton, ON

Drawing Title PROPOSED COVER PATIO ELEVATIONS

Drawn by **DONYA AWASI**

Scale 1'-0" = 1/8"

October 2024

№ — 6

Table 1.2 (Cont'd) Design Data for Selected Locations in Ontario

	Design Temperature				Degree			Assurat	Annual	Driving Rain	Snow Load,		Hourly Wind Pressures, kPa		Seismic Data				
Location	January July 2		2.5%	Days Below	Rainfall,	One Day Rainfall,	Annual Rainfall,	Total Precipita-	Wind Pressures,	kPa, 1/50		100	4/50	0 (0.0)	S _s (0.5)	S _a (1.0)	Sa(2.0)	PGA	
		1%, °C	Dry, °C	Wet,	18°C	mm	1/50, mm	mm	tion, mm	Pa, 1/5	1/10 S _s S _r		1/10	1/50	S _a (0.2)	S ₈ (0.5)	Sa(1.0)	Ja(2.0)	10/1
			- 00		6250	20	86	550	825	100	2.8	0.3	0.24	0.31	0.110	0.068	0.042	0.014	0.045
Kapuskasing	-34	-36	29	21	4540	25	92	750	925	160	2.3	0.4	0.32	0.41	0.560	0.280	0.130	0.042	0.280
Kemptville	-25	-27	30	23	5630	25	113	515	630	120	2.3	0.3	0.24	0.31	0.095	0.057	0.026	0.008	0.036
Kenora	-33	-35	28	22		23	86	680	825	120	2.7	0.4	0.27	0.35	0.440	0.230	0.110	0.036	0.210
Killaloe	-28	-31	30	22	4960	-	92	800	950	180	2.6	0.4	0.43	0.55	-0:110-	0.075	0.049	0.016	0.030
Kincardine	-17	-19	28	22	3890	25		-	950	180	2.1	0.4	0.36	0.47	0.290	0.180	0.099	0.031	0.12
Kingston	-22	-24	28	23	4000	23	108	780	950	120	2.7	0.4	0.30	0.47	0.200	0.140	0.077	0.026	0.06
Kinmount	-26	-28	29	23	4600	25	108	750	875	100	2.9	0.3	0.30	0.39	0.220	0.120	0.069	0.022	0.10
Kirkland Lake	-33	-36	29	22	6000	23	92	600	2000	140	2.0	0.4	0.29	0.37	0.160	0.095	0.058	0.018	0.05
Kitchener	-19	-21	29	23	4200	28	119	780	925	-	2.0	0.4	0.29	0.38	0.200	0.140	0.079	0.026	0.06
Lakefield	-24	-26	30	23	4330	25	92	720	850	140	-	0.4	0.25	0.32	0.200	0.057	0.026	0.008	0.03
Lansdowne House	-38	-40	28	21	7150	23	92	500	680	140	0.8	0.2	0.25	0.32	0.093	0.092	0.020	0.015	0.09
Leamington	-15	-17	31	24	3400	28	113	800	875	180	100000	North I	0.29	0.38	0.170	0.120	0.074	0.024	0.05
Lindsay	-24	-26	30	23	4320	25	103	720	850	140	2.3	0.4	557833	0.30	0.100	0.082	0.074	0.024	0.03
Lion's Head	-19	-21	27	22	4300	25	103	700	950	180	2.7	0.4	0.37	0.46	0.110	0.085	0.054	0.018	0.04
Listowel	-19	-21	29	23	4300	28	119	800	1000	160	2.6	0.4	0.36		-		0.055	0.017	0.07
London	-18	-20	30	24	3900	28	103	825	975	180	1.9	0.4	0.36	0.47	0.150	0.093	0.055	0.017	0.04
Lucan	-17	-19	30	23	3900	25	113	810	1000	180	2.3	0.4	0.39	0.50	0.130		0.120	0.036	0.15
Maitland	-23	-25	29	23	4080	25	103	770	975	180	2.2	0.4	0.34	0.44	0.370	0.220	0.120	0.036	0.04
Markdale	-20	-22	29	22	4500	28	103	820	1050	160	3.4	0.4	0.32	0.41	0.120	0.088		-	0.00
Markham	-21	-23	31	24	4000	25	86	720	825	140	1.3	0.4	0.34	0.44	0.180	0.110	0.067	0.022	0.00
Martin	-35	-37	29	22	5900	25	103	560	750	120	2.6	0.3	0.23	0.30	0.095	0.057	0.026	0.008	0.0
Matheson	-33	-36	29	21	6080	20	86	580	825	100	2.8	0.3	0.30	0.39	0.200	0.110	0.063	0.020	0.0
Mattawa	-29	-31	30	22	5050	23	86	700	875	100	2.1	0.4	0.25	0.32	0.460	0.230	0.100	0.035	-
Midland	-24	-26	29	23	4200	25	97	740	1060	160	2.7	0.4	0.30	0.39	0.150	0.110	0.064	0.022	0.0
Milton	-18	-20	30	23	3920	25	125	750	850	160	1.3	0.4	0.33	0.43	0.260	0.140	0.063	0.020	0.1
Column 1	2	3	4	5	6	7	8	9	10	11	12	13	14	15	16	17	18	19	20



1316 Britton Cres Milton, ON

Drawing Title

GENERAL INFORMATION

Drawn by **BONHA ABASI**

Scale 1'-0" = 1/8"

October 2024

f 24



Report To: Committee of Adjustment and Consent

From: Madison Polidoro

Date: November 28, 2024

File No: A-24-053M

Subject: 1261 Rose Way

Recommendation: THAT the application for minor variance BE APPROVED

SUBJECT TO THE FOLLOWING CONDITION:

1. That the development shall be located and constructed in accordance with the site plan and building elevations, prepared by Farrukh Shahbaz, date stamped by Town Zoning on October 16th, 2024:

- 2. That a Residential Sprinkler System be included in the plans submitted for Building Permit;
- 3. That a building permit application be obtained within two (2) years from the date of this decision; and,
- 4. That the approval be subject to an expiry of two (2) years from the date of decision if the conditions are not met, if the proposed development does not proceed and/or a building permit is not secured.

General Description of Application

Under Section 45(1) of the Planning Act, the following minor variance to Zoning By-law 016-2014, as amended, has been requested to permit:

 Allow an existing porch to encroach 0.24 metres into a required 1.2 metre unobstructed pedestrian access, whereas the Zoning By-law does not permit porches to encroach in the 1.2 metre unobstructed pedestrian access.

The subject property is known municipally as 1261 Rose Way and is generally located southeast of the intersection of Louis St. Laurent Avenue and Regional Road 25. Surrounding uses are in primarily residential and are mainly comprised of single detached dwellings.

The subject lands currently contain a two-storey single detached dwelling with an attached garage. The applicant is proposing to construct an Additional Dwelling Unit in the basement. The applicant is seeking relief to the by-law to permit an existing porch to encroach into the 1.2 metre unobstructed pedestrian access.

Official Plan Designation (including any applicable Secondary Plan designations)

The subject property is designated Residential Area on Schedule B - Urban Land Use Plan within the Town of Milton Official Plan and is further designated Residential Area within the Boyne Survey



File #: A-24-053M Page 2 of 3

Official Plan Designation (including any applicable Secondary Plan designations)

Secondary Plan. These designations establish that the primary use of land shall be a mix of low, medium and high-density residential development. A variety of medium and high-density residential uses are permitted. Additional Residential Units are permitted as-of-right in the residential area, subject to the criteria as set out in Section 2.7.3.17 and 2.7.3.18.

It is Staff's opinion that the proposal is in conformity with the Town of Milton Official Plan.

Zoning

The subject lands are zoned Residential Medium Density (RMD1*315) under the Town of Milton Zoning By-law 016-2014, as amended. The RMD1*315 zone permits a variety of residential uses, including detached and townhouse dwellings.

Section 4.10 vi) of the Zoning By-law requires an unobstructed pedestrian access with a minimum width of 1.2 metre. The applicant is seeking relief to allow an existing porch to encroach within the access by 0.24 metres, resulting in a setback of 0.96 metres.

Consultation

Public Consultation

Notice for the hearing was provided pursuant to the Planning Act on November 13th, 2024. As of the writing of this report on, November 20th 2024, staff have not received any comments from members of the public.

Agency Consultation

No objections were filed with respect to the variance application from Town staff or external agencies.

Development Services Comments

In order for a permit to be issued to construct an Additional Residential Unit, all relevant Zoning By-law provisions must be met, including the provision of the 1.2 metre unobstructed pedestrian access. The home has an existing porch currently obstructing the 1.2 metre access and results in a setback of 0.96 metres where the porch is located.

The intention of the 1.2 metre unobstructed pedestrian access is to allow for a free and clear path of travel for both the residents' use, along with fire and life safety personnel. The Zoning By-law permits certain encroachments (i.e. window wells) up to 0.30 metres within the required unobstructed pedestrian access; however, porches are not included in the list of permitted encroachments.

Planning Staff is of the opinion that permitting the porch to encroach 1.2 metres into the required unobstructed access will not hinder the intended function of the pedestrian access nor pose a hazard to users. Further, the Town of Milton Fire department was circulated on the application and did not have any concerns regarding the application, subject to the applicant installing residential sprinklers within the unit.



File #: A-24-053M Page 3 of 3

Consultation

Planning Staff have reviewed the request to allow a porch to encroach 0.24 metres into the side yard setback and offer no objection to the proposed variance approval. Planning Staff are of the opinion that the relief being requested is minor in nature, desirable for the development of the subject lands, maintains the intent of the Zoning By-law and conforms to the Official Plan.

Respectfully submitted,


Madison Polidoro

Planner, Development Review

For questions, please contact: Madison.Polidoro@Milton.ca Phone: Ext. 2311

Attachments

Figure 1 - Site Plan (1261 Rose Way) dated October 16th, 2024.

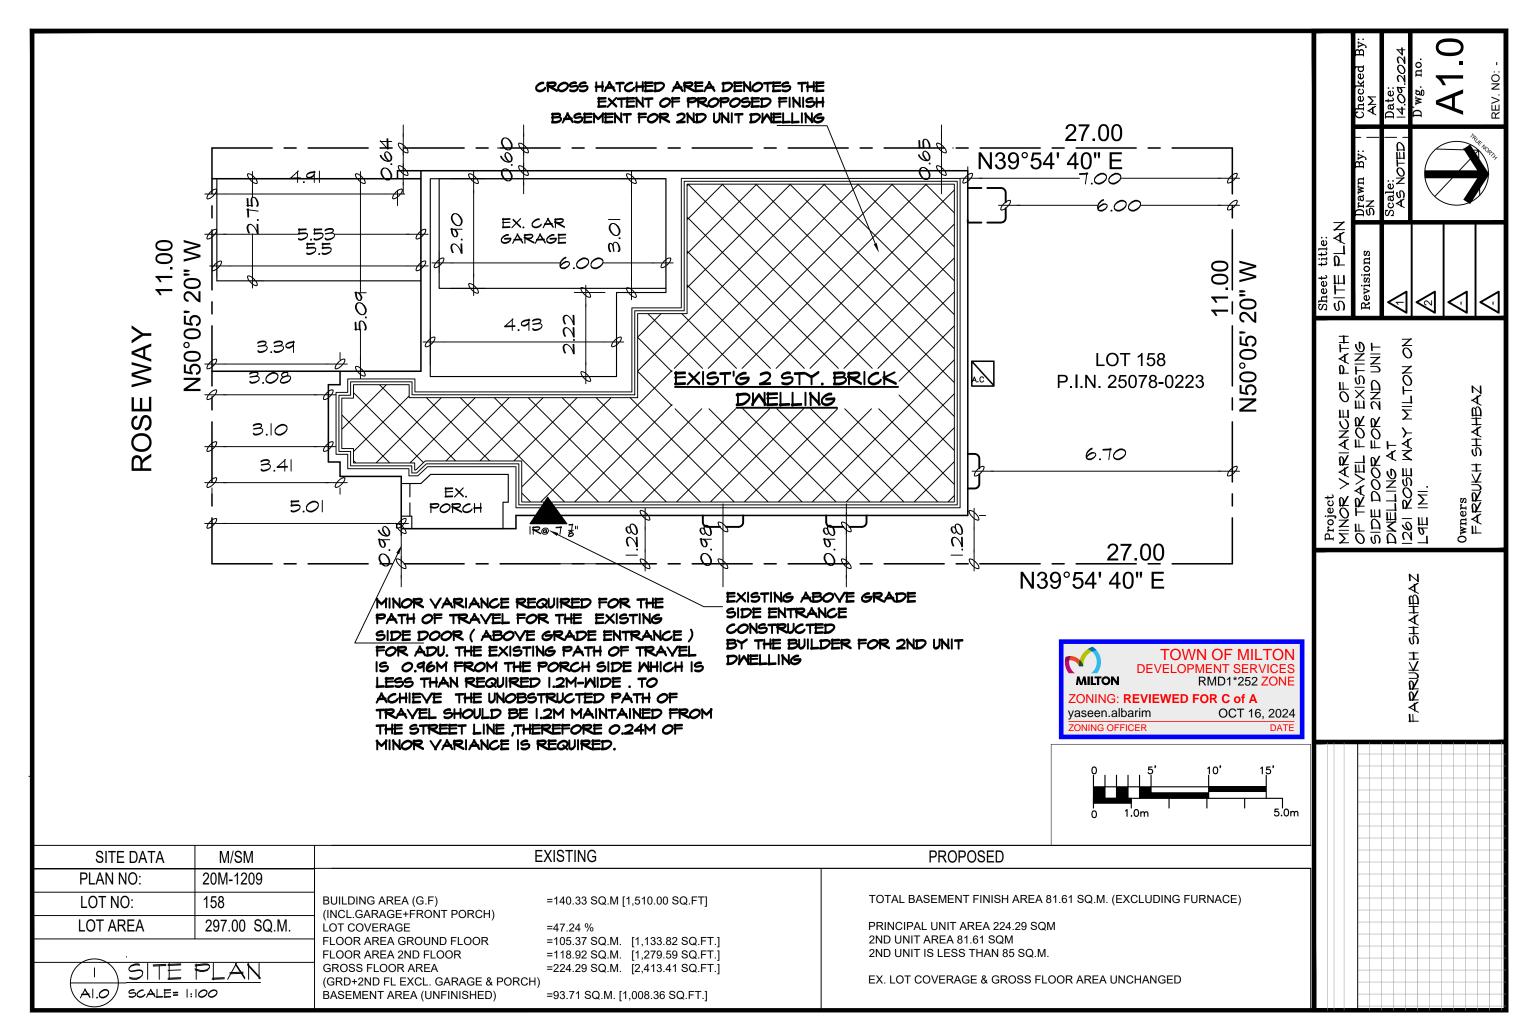



Report To: Committee of Adjustment and Consent

From: Madison Polidoro

Date: November 28, 2024

File No: A-24-054M

Subject: 1416 Sycamore Garden

Recommendation: THAT the application for minor variance BE APPROVED SUBJECT TO THE FOLLOWING CONDITION:

1. That the development shall be located and constructed in accordance with the site plan and building elevations, prepared by Shivang Tarika. date stamped by Town Zoning on November 5th, 2024.

- 2. That a Residential Sprinkler System be included in the plans submitted for Building Permit;
- 3. That a Building Permit be issued within two (2) years from the date of this decision; and,
- That the approval be subject to an expiry of two (2) years from the date of decision if the conditions are not met, if the proposed development does not proceed and/or a Building Permit is not secured.

General Description of Application

Under Section 45(1) of the Planning Act, the following minor variance to Zoning By-law 016-2014, as amended, has been requested to permit:

 Allow an existing chimney to encroach 0.25 metres into a required 1.2 metre unobstructed pedestrian access, whereas the Zoning By-law does not permit chimneys to encroach in the 1.2 metre unobstructed pedestrian access.

The subject property is known municipally as 1416 Sycamore Garden and is generally located north west of the intersection of Thompson Road South and Britannia Road. Surrounding uses are in primarily residential and are mainly comprised of single detached dwellings.

The subject lands currently contain a two-storey single detached dwelling with an attached garage. The applicant is proposing to construct an Additional Residential Unit in the basement. The applicant is seeking relief to the by-law to permit a chimney to encroach into the unobstructed pedestrian access resulting in a setback of 0.95 metres.



File #: A-24-054M Page 2 of 3

Official Plan Designation (including any applicable Secondary Plan designations)

The subject property is designated Residential Area on Schedule B - Urban Land Use Plan within the Town of Milton Official Plan and is further designated Residential Area within the Boyne Survey Secondary Plan. These designations establish that the primary use of land shall be a mix of low, medium and high-density residential development. A variety of medium and high-density residential uses are permitted. Additional Residential Units are permitted as-of-right in the residential area, subject to the criteria as set out in Section 2.7.3.17 and 2.7.3.18.

It is Staff's opinion that the proposal is in conformity with the Town of Milton Official Plan

Zoning

The subject lands are zoned Residential Medium Density (RMD1*264) under the Town of Milton Zoning By-law 016-2014, as amended. The RMD1*264 zone permits a variety of residential uses, including detached and townhouse dwellings.

Section 4.10 vi) of the Zoning By-law requires an unobstructed pedestrian access with a minimum width of 1.2 metres. The applicant is seeking relief to allow and existing chimney to encroach within the access by 0.25 metres, resulting in a setback of 0.95 metres.

Consultation

Public Consultation

Notice for the hearing was provided pursuant to the Planning Act on November 13th, 2024. As of the writing of this report on, November 20th 2024, staff have not received any comments from members of the public.

Agency Consultation

No objections were filed with respect to the variance application from Town staff or external agencies.

Development Services Comments

In order for a permit to be issued to construct an Additional Residential Unit, all relevant Zoning By-law provisions must be met, including the provision of the 1.2 metre unobstructed pedestrian access. The home has an existing chimney currently obstructing the 1.2 metre access and results in a setback of 0.95 metres where the chimney is located.

The intention of the 1.2 metre unobstructed pedestrian access is to allow for a free and clear path of travel for both the residents' use, along with fire and life safety personnel. The Zoning By-law permits certain encroachments (i.e. window wells) up to 0.30 metres within the required unobstructed pedestrian access; however, chimneys are not included in the list of permitted encroachments.

Planning Staff is of the opinion that permitting the chimney to encroach 1.2 metres into the required unobstructed access will not hinder the intended function of the pedestrian access nor pose a



File #: A-24-054M Page 3 of 3

Consultation

hazard to users. Further, the Town of Milton Fire department was circulated on the application and did not have any concerns regarding the application, subject to the applicant installing residential sprinklers within the unit.

Planning Staff have reviewed the request to allow a chimney to encroach 0.25 metres into the side yard setback and offer no objection to the proposed variance approval. Planning Staff are of the opinion that the relief being requested is minor in nature, desirable for the development of the subject lands, maintains the intent of the Zoning By-law and conforms to the Official Plan.

Respectfully submitted,


Madison Polidoro

Planner, Development Review

For questions, please contact: Madison.Polidoro@Milton.ca Phone: Ext. 2311

Attachments

Figure 1 - Site Plan (1416 Sycamore Garden) dated November 5th, 2024

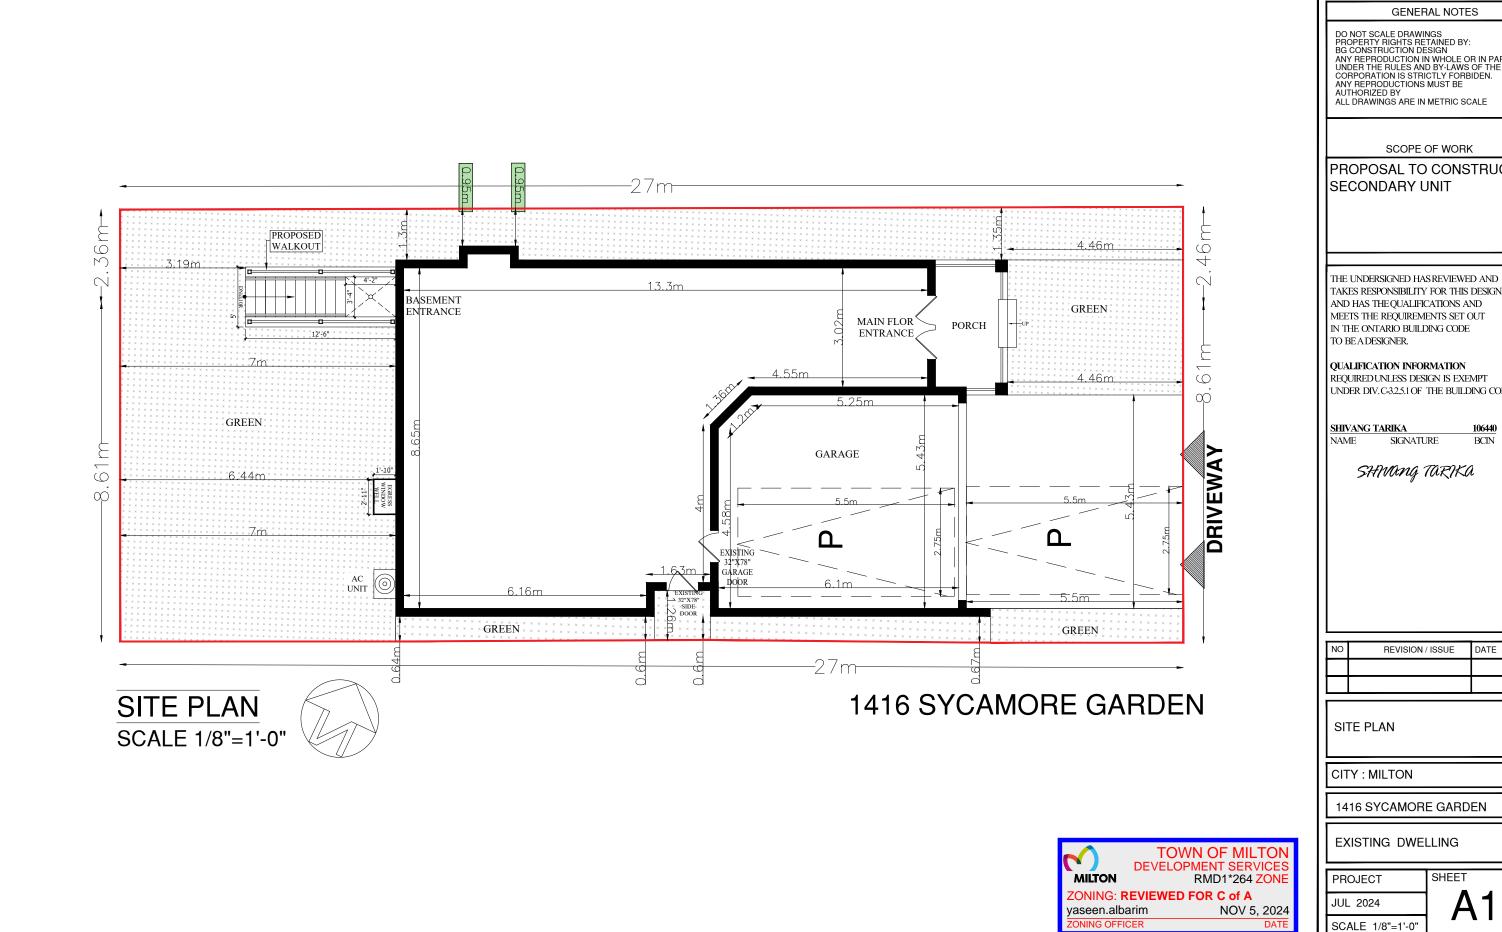

DO NOT SCALE DRAWINGS
PROPERTY RIGHTS RETAINED BY:
BG CONSTRUCTION DESIGN
ANY REPRODUCTION IN WHOLE OR IN PART
UNDER THE RULES AND BY-LAWS OF THE
CORPORATION IS STRICTLY FORBIDEN.
ANY REPRODUCTIONS MUST BE
AUTHORIZED BY
ALL DRAWINGS ARE IN METRIC SCALE

SCOPE OF WORK

PROPOSAL TO CONSTRUCT

TAKES RESPONSIBILITY FOR THIS DESIGN, AND HAS THE QUALIFICATIONS AND MEETS THE REQUIREMENTS SET OUT IN THE ONTARIO BUILDING CODE

UNDER DIV. C-3.2.5.1 OF THE BUILDING CODE

106440 SIGNATURE

SHWANG TARIKA

REVISION / ISSUE DATE

1416 SYCAMORE GARDEN

SHEET